

N/A

LEGEND

PROJECT

DISCLAIMER





This house plan is a guide only. It does not constitute legal or other professional advice. You should seek legal or other professional advice in relation to your specific

Commonwealth also disclaims liability, to the extent permitted by law, for any liabilities, losses, damages and costs arising from any reliance on the contents of this plan.

circumstances before adopting any recommendation made within it e.g. advice on structural engineering or building certification requirements. The Commonwealth does not

accept responsibility for the accuracy or completeness of this plan, its fitness for a particular purpose, or compliance with any regulatory requirements and standards. Further, the



DESIGN Acacia House

DESIGNED FOR

Brisbane - Option 1

Technical drawings should be read with the Acacia House Brisbane 'Design Options' document which includes building specifications and rating information.

DETAILS

Drawing title: Site Plan


Scale: 1:200
Paper size: A3

Drawing number: 1/10

Date issued: March 2020

Project stage: Preliminary



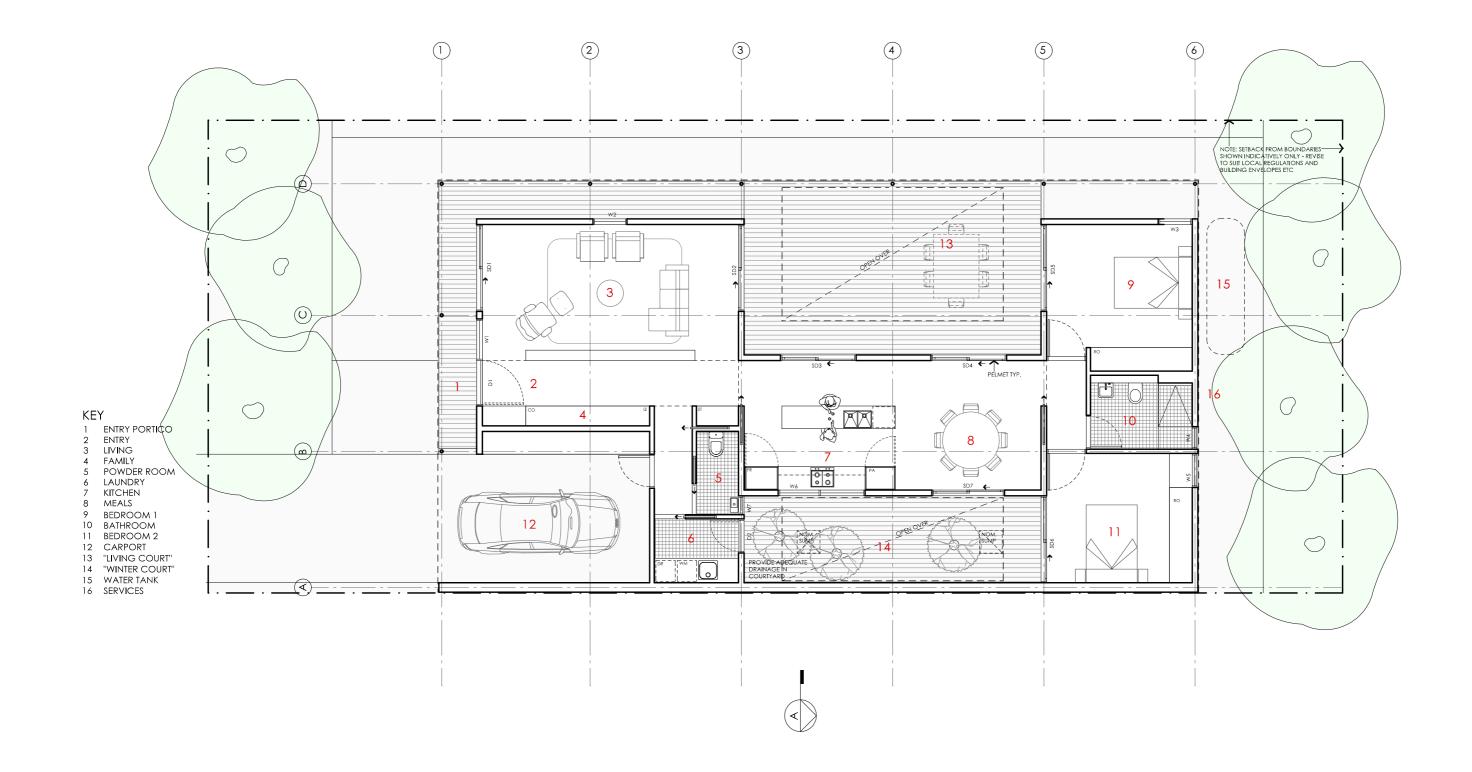

NOTES

GFL LIVING 123 m2 CARPORT 23 m2

TOTAL GFA 146 m2 (including carport)

NOTE: GFA CALCULATIONS DO NOT INCLUDE DECKS, TERRACES, COURTYARDS, VERANDAHS, VOIDS, STAIRS & BALCONIES ® UE. NOTE THAT INTERNAL ROOM DIMENSIONS ARE NOMINAL ONLY AND GENERALLY INCLUDE JOINERY WITHIN THOSE DIMENSIONS.

PROJECT







laca

DESIGNED FOR

Acacia House

DESIGN

Brisbane - Option 1

Technical drawings should be read with the Acacia House Brisbane 'Design Options' document which includes building specifications and rating information.

DETAILS

Drawing title: Floor Plan


Scale: 1:100
Paper size: A3

Drawing number: 2/10

Date issued: March 2020
Project stage: Preliminary



DISCLAIMER

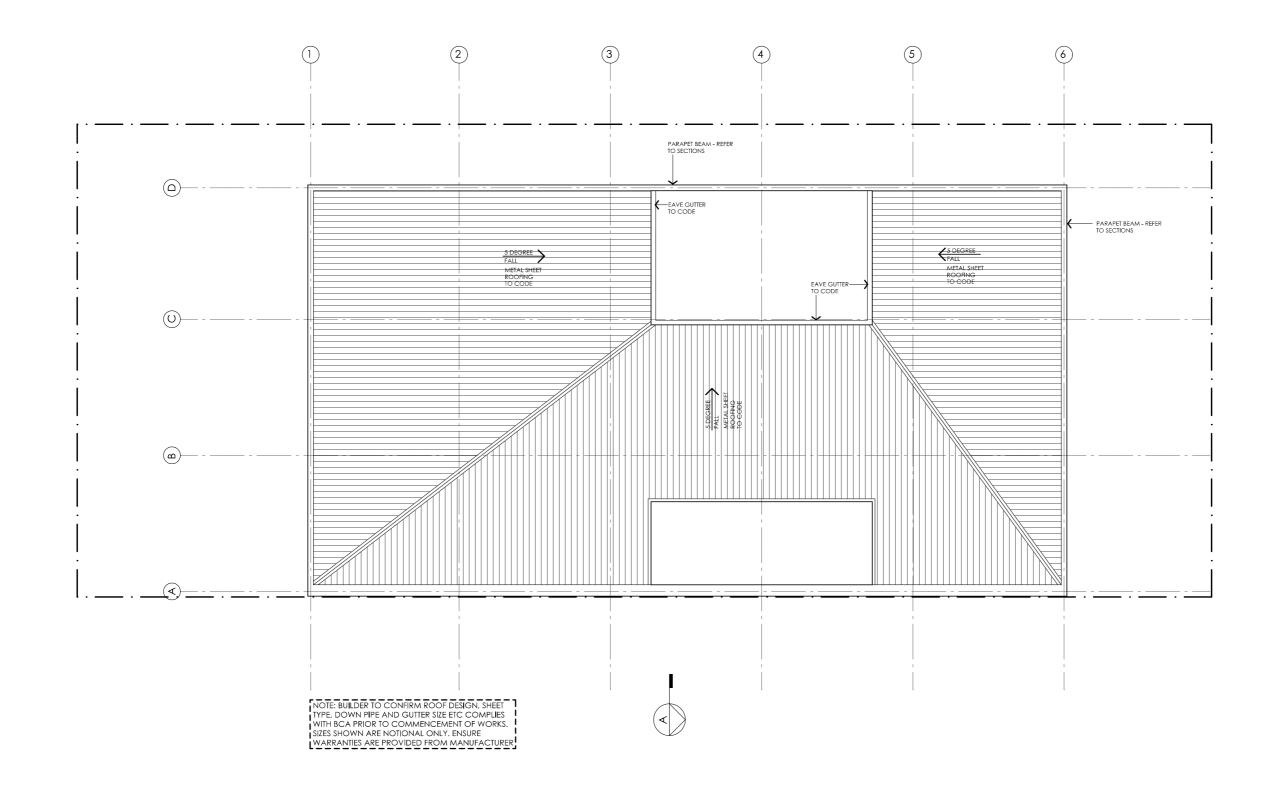

NOTES

GFL LIVING 123 m2 CARPORT 23 m2

TOTAL GFA 146 m2 (including carport)

NOTE: GFA CALCULATIONS DO NOT INCLUDE DECKS, TERRACES, COURTYARDS, VERANDAHS, VOIDS, STAIRS & BALCONIES ® UFL. NOTE THAT INTERNAL ROOM DIMENSIONS ARE NOMINAL ONLY AND GENERALLY INCLUDE JOINERY WITHIN THOSE DIMENSIONS.

PROJECT

DISCLAIMER





This house plan is a guide only. It does not constitute legal or other professional advice. You should seek legal or other professional advice in relation to your specific

Commonwealth also disclaims liability, to the extent permitted by law, for any liabilities, losses, damages and costs arising from any reliance on the contents of this plan.

circumstances before adopting any recommendation made within it e.g. advice on structural engineering or building certification requirements. The Commonwealth does not

 $accept \ responsibility \ for \ the \ accuracy \ or \ completeness \ of \ this \ plan, its \ fitness \ for \ a \ particular \ purpose, or \ compliance \ with \ any \ regulatory \ requirements \ and \ standards. Further, the$



Brisbane - Option 1

DESIGNED FOR

DESIGN

Acacia House

Technical drawings should be read with the Acacia House Brisbane 'Design Options' document which includes building specifications and rating information.

DETAILS

Drawing title: Roof Plan


Scale: 1:100
Paper size: A3

Drawing number: 3/10

Project stage: Preliminary

Date issued: March 2020



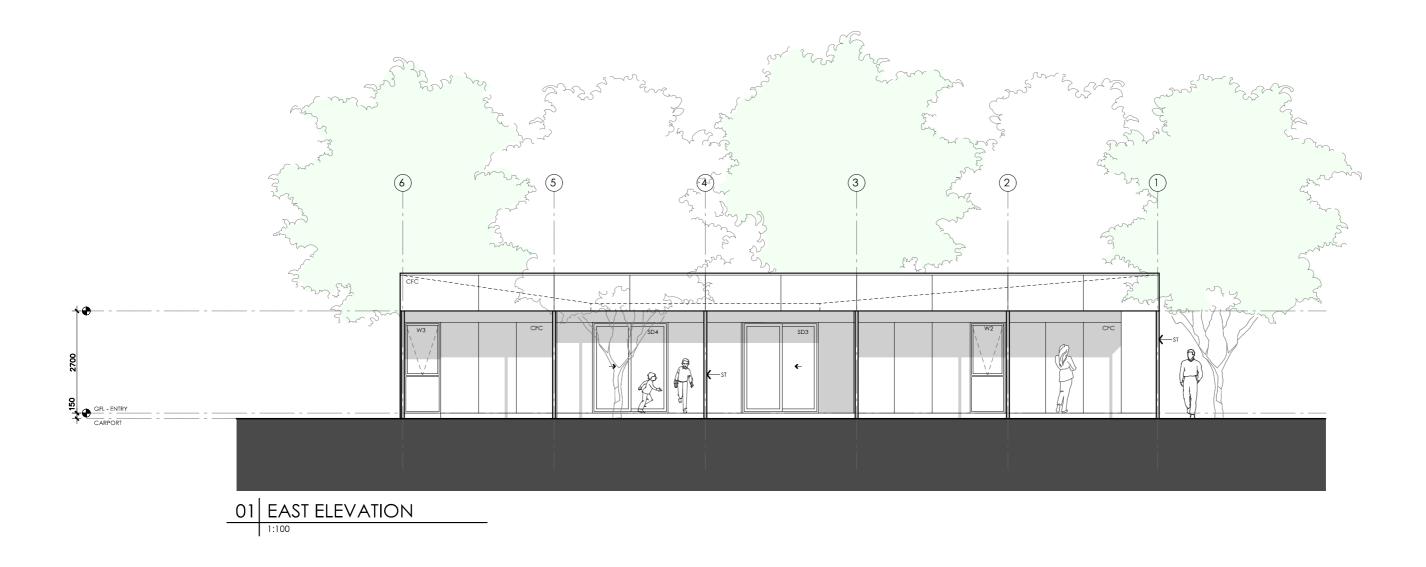

LEGEND

- BW FACE BRICK WALL TYPE & COLOUR TBC
- WB WEATHERBOARD CLADDING TYPE & COLOUR TBC
- CFC COMPRESSED FC SHEET ON TIMBER FRAME EXPRESSED JOINT AT EDGES INDICATED
- MF FOLDED METAL FASCIA COLOUR TBC
- ST STEEL WORK COLOUR TBC
- GD GARAGE DOOR COLOUR TBC
- ALUMINIUM COVER PLATE COLOUR TO MATCH WINDOW FRAMES

PROJECT







DESIGN Acacia House

DESIGNED FOR Brisbane - Option 1

Technical drawings should be read with the Acacia House Brisbane 'Design Options' document which includes building specifications and rating information.

DETAILS

Drawing title: Elevation

Scale: 1:100 Paper size: A3

Drawing number: 4/10 Date issued: March 2020 Project stage: Preliminary

DISCLAIMER



LEGEND

- BW FACE BRICK WALL TYPE & COLOUR TBC
- WB WEATHERBOARD CLADDING TYPE & COLOUR TBC
- CFC COMPRESSED FC SHEET ON TIMBER FRAME EXPRESSED JOINT AT EDGES INDICATED
- MF FOLDED METAL FASCIA COLOUR TBC
- ST STEEL WORK COLOUR TBC
- GD GARAGE DOOR COLOUR TBC
- ALUMINIUM COVER PLATE COLOUR TO MATCH WINDOW FRAMES

PROJECT

DISCLAIMER





This house plan is a guide only. It does not constitute legal or other professional advice. You should seek legal or other professional advice in relation to your specific

Commonwealth also disclaims liability, to the extent permitted by law, for any liabilities, losses, damages and costs arising from any reliance on the contents of this plan.

circumstances before adopting any recommendation made within it e.g. advice on structural engineering or building certification requirements. The Commonwealth does not

accept responsibility for the accuracy or completeness of this plan, its fitness for a particular purpose, or compliance with any regulatory requirements and standards. Further, the



DESIGN Acacia House

DESIGNED FOR Brisbane - Option 1

Technical drawings should be read with the Acacia House Brisbane 'Design Options' document which includes building specifications and rating information.

DETAILS

Drawing title: Elevation

Scale: 1:100 Paper size: A3

Drawing number: 5/10 Date issued: March 2020 Project stage: Preliminary



LEGEND

- BW FACE BRICK WALL TYPE & COLOUR TBC
- WB WEATHERBOARD CLADDING TYPE & COLOUR TBC
- CFC COMPRESSED FC SHEET ON TIMBER FRAME EXPRESSED JOINT AT EDGES INDICATED
- MF FOLDED METAL FASCIA COLOUR TBC
- ST STEEL WORK COLOUR TBC
- GD GARAGE DOOR COLOUR TBC
- ALUMINIUM COVER PLATE COLOUR TO MATCH WINDOW FRAMES

PROJECT







DESIGN Acacia House

DESIGNED FOR Brisbane - Option 1

Technical drawings should be read with the Acacia House Brisbane 'Design Options' document which includes building specifications and rating information.

DETAILS


Drawing title: Elevation

Scale: 1:100 Paper size: A3

Drawing number: 6/10 Date issued: March 2020

Project stage: Preliminary

DISCLAIMER

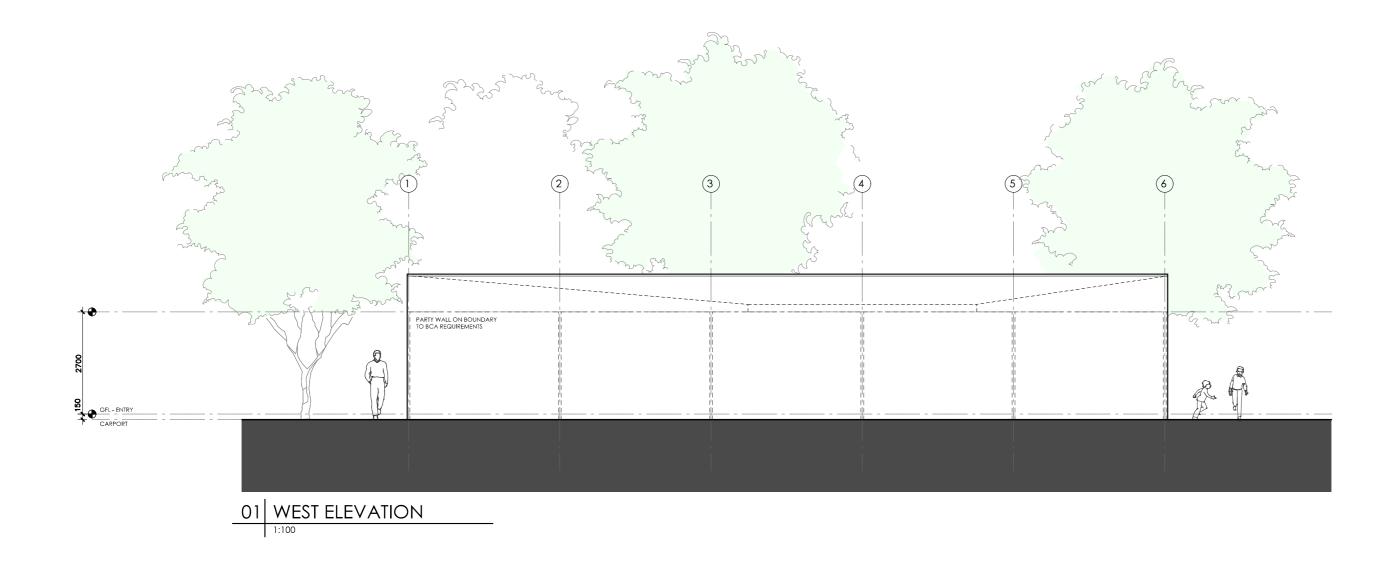

LEGEND

- BW FACE BRICK WALL TYPE & COLOUR TBC
- WB WEATHERBOARD CLADDING TYPE & COLOUR TBC
- CFC COMPRESSED FC SHEET ON TIMBER FRAME EXPRESSED JOINT AT EDGES INDICATED
- MF FOLDED METAL FASCIA COLOUR TBC
- ST STEEL WORK COLOUR TBC
- GD GARAGE DOOR COLOUR TBC
- ALUMINIUM COVER PLATE COLOUR TO MATCH WINDOW FRAMES

PROJECT

DISCLAIMER







DESIGNED FOR Brisbane - Option 1

DESIGN

Acacia House

Technical drawings should be read with the Acacia House Brisbane 'Design Options' document which includes building specifications and rating information.

DETAILS

Drawing title: Elevation

Scale: 1:100 Paper size: A3

Drawing number: 7/10 Date issued: March 2020 Project stage: Preliminary

This house plan is a guide only. It does not constitute legal or other professional advice. You should seek legal or other professional advice in relation to your specific circumstances before adopting any recommendation made within it e.g. advice on structural engineering or building certification requirements. The Commonwealth does not

accept responsibility for the accuracy or completeness of this plan, its fitness for a particular purpose, or compliance with any regulatory requirements and standards. Further, the Commonwealth also disclaims liability, to the extent permitted by law, for any liabilities, losses, damages and costs arising from any reliance on the contents of this plan.



LEGEND

- BW FACE BRICK WALL TYPE & COLOUR TBC
- WB WEATHERBOARD CLADDING TYPE & COLOUR TBC
- CFC COMPRESSED FC SHEET ON TIMBER FRAME EXPRESSED JOINT AT EDGES INDICATED
- MF FOLDED METAL FASCIA COLOUR TBC
- ST STEEL WORK COLOUR TBC
- GD GARAGE DOOR COLOUR TBC
- ALUMINIUM COVER PLATE COLOUR TO MATCH WINDOW FRAMES

PROJECT







DESIGN Acacia House

DESIGNED FOR Brisbane - Option 1

Technical drawings should be read with the Acacia House Brisbane 'Design Options' document which includes building specifications and rating information.

DETAILS


Drawing title: Section

Scale: 1:100 Paper size: A3

Drawing number: 8/10 Date issued: March 2020

Project stage: Preliminary

DISCLAIMER

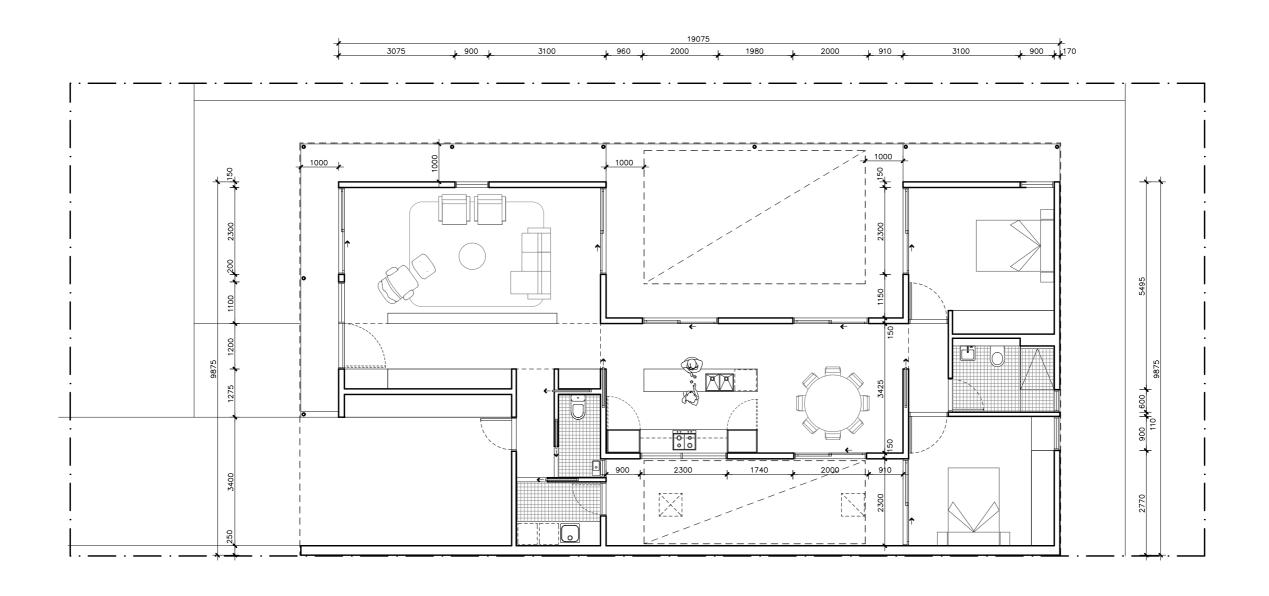



REFERENCE	HEIGHT	WIDTH	TYPE	NOTES
D1	2400mm	1100mm	Solid door	1000mm Eave at 2700mm above Finished Floor Level
SD1	2400mm	2300mm	Glazed sliding door	1000mm Eave at 2700mm above Finished Floor Level
W1	2400mm	1100mm	Fixed window	1000mm Eave at 2700mm above Finished Floor Level
W2	2400mm	900mm	Fixed / awning window	1000mm Eave at 2700mm above Finished Floor Level See elevations for breakdown of opening types
SD2	2400mm	2300mm	Glazed sliding door	1000mm Eave at 2700mm above Finished Floor Level
SD3	2400mm	2000mm	Glazed sliding door	1000mm Eave at 2700mm above Finished Floor Level
SD4	2400mm	2000mm	Glazed sliding door	1000mm Eave at 2700mm above Finished Floor Level
SD5	2400mm	2300mm	Glazed sliding door	1000mm Eave at 2700mm above Finished Floor Level
W3	2400mm	900mm	Fixed / awning window	1000mm Eave at 2700mm above Finished Floor Level See elevations for breakdown of opening types
W4	1440mm	600mm	Awning window	
W5	2400mm	900mm	Fixed / awning window	See elevations for breakdown of opening types
SD6	2400mm	2300mm	Glazed sliding door	1000mm Eave at 2700mm above Finished Floor Level
SD7	2400mm	2000mm	Glazed sliding door	
W6	800mm	2300mm	Fixed window	
W7	600mm	600mm	Sliding window	1000mm Eave at 2700mm above Finished Floor Level
D2	2250mm	820mm	Glazed hinged door	1000mm Eave at 2700mm above Finished Floor Level

LEGEND

N/A

PROJECT







esign For Place

DESIGNED FOR Brisbane - Option 1

DESIGN

Acacia House

Technical drawings should be read with the Acacia House Brisbane 'Design Options' document which includes building specifications and rating information.

DETAILS

Drawing title: Window and Door

Schedule


Scale: N/A
Paper size: A3

Drawing number: 10/10

Date issued: March 2020

Project stage: Preliminary

DISCLAIMER

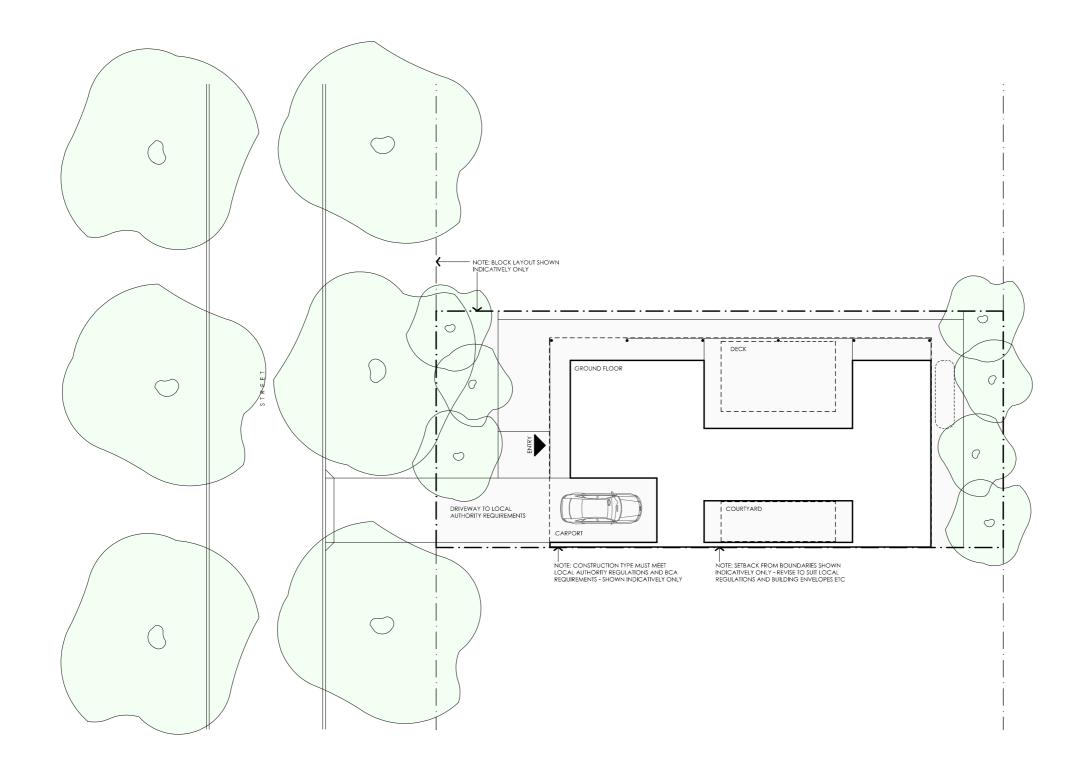

N/A

LEGEND

PROJECT

DISCLAIMER





This house plan is a guide only. It does not constitute legal or other professional advice. You should seek legal or other professional advice in relation to your specific

Commonwealth also disclaims liability, to the extent permitted by law, for any liabilities, losses, damages and costs arising from any reliance on the contents of this plan.

circumstances before adopting any recommendation made within it e.g. advice on structural engineering or building certification requirements. The Commonwealth does not

accept responsibility for the accuracy or completeness of this plan, its fitness for a particular purpose, or compliance with any regulatory requirements and standards. Further, the



DESIGN Acacia House

DESIGNED FOR

Brisbane - Option 2

Technical drawings should be read with the Acacia House Brisbane 'Design Options' document which includes building specifications and rating information.

DETAILS

Drawing title: Site Plan


Scale: 1:200
Paper size: A3

Drawing number: 1/10

Project stage: Preliminary

Date issued: March 2020



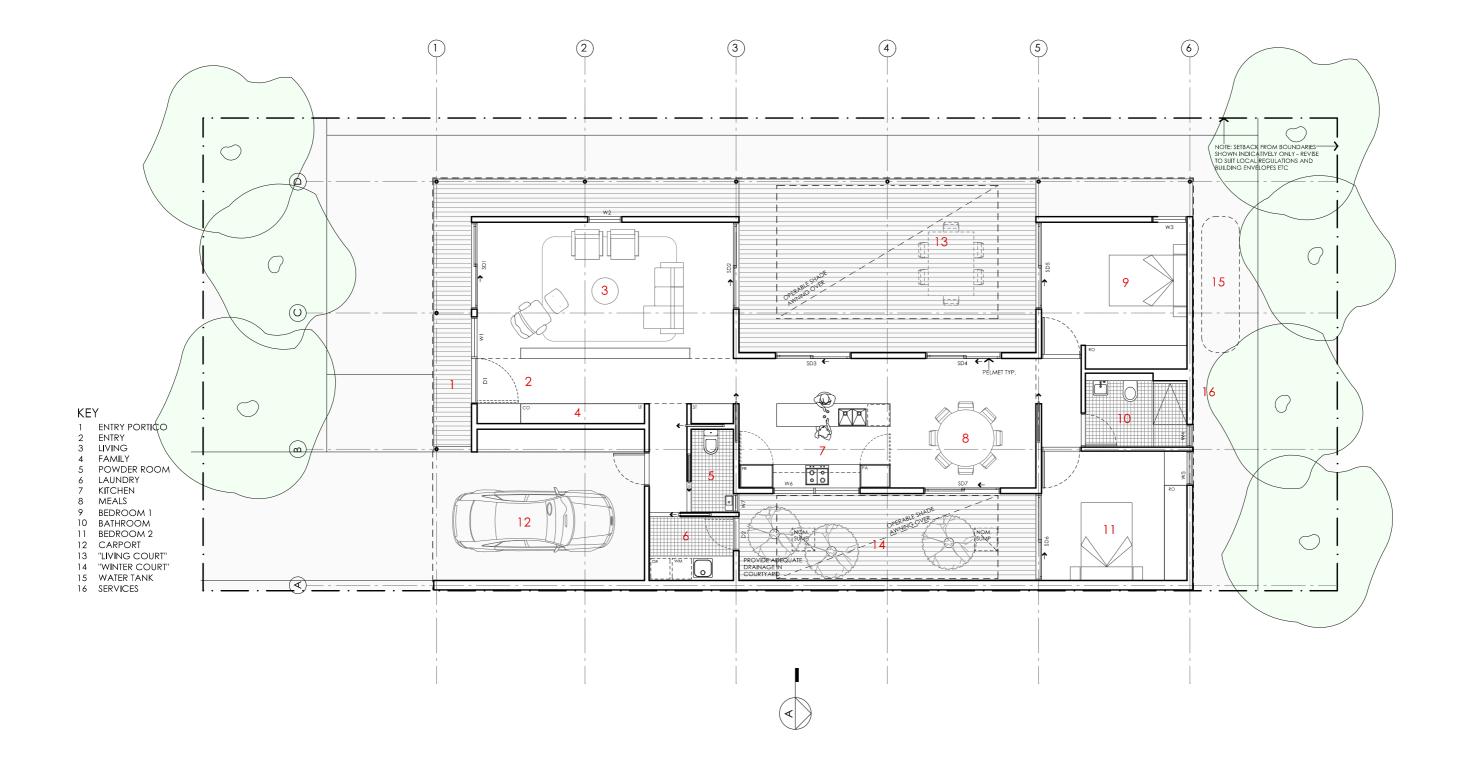

NOTES

GFL LIVING 123 m2 CARPORT 23 m2

TOTAL GFA 146 m2 (including carport)

NOTE: GFA CALCULATIONS DO NOT INCLUDE DECKS, TERRACES, COURTYARDS, VERANDAHS, VOIDS, STAIRS & BALCONIES ® UFL. NOTE THAT INTERNAL ROOM DIMENSIONS ARE NOMINAL ONLY AND GENERALLY INCLUDE JOINERY WITHIN THOSE DIMENSIONS.

PROJECT







DESIGNED FOR

Brisbane - Option 2

DESIGN

Acacia House

Technical drawings should be read with the Acacia House Brisbane 'Design Options' document which includes building specifications and rating information.

DETAILS

Drawing title: Floor Plan

Scale: 1:100
Paper size: A3


Drawing number: 2/10

Project stage: Preliminary

Date issued: March 2020



DISCLAIMER

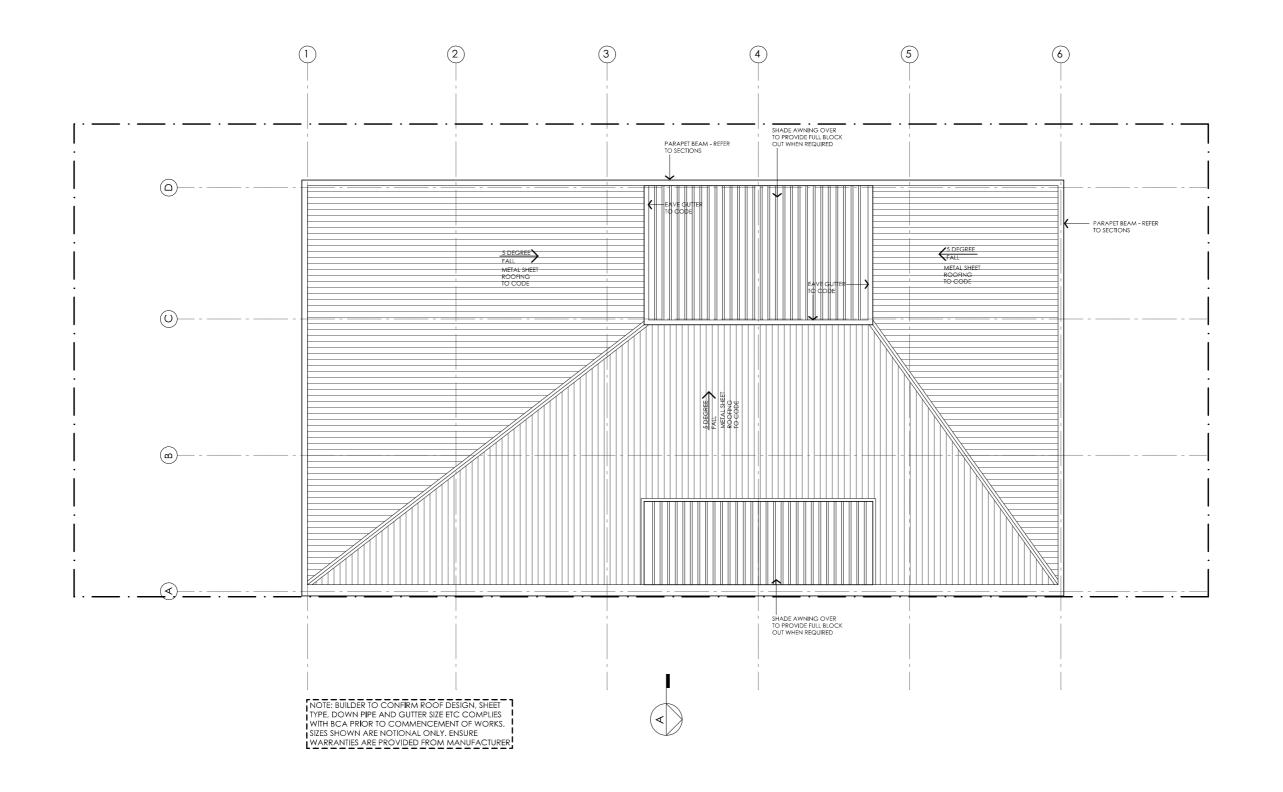

GFL LIVING 123 m2 CARPORT 23 m2 TOTAL GFA 146 m2 (including carport) DISCLAIMER NOTE: GFA CALCULATIONS DO NOT INCLUDE DECKS, TERRACES, COURTYARDS, VERANDAHS, VOIDS, STAIRS & BALCONIES ® UFL. NOTE THAT INTERNAL ROOM DIMENSIONS ARE NOMINAL ONLY AND GENERALLY INCLUDE JOINERY WITHIN THOSE DIMENSIONS. This house plan is a guide only. It does not constitute legal or other professional advice. You should seek legal or other professional advice in relation to your specific

NOTES

PROJECT





circumstances before adopting any recommendation made within it e.g. advice on structural engineering or building certification requirements. The Commonwealth does not

Commonwealth also disclaims liability, to the extent permitted by law, for any liabilities, losses, damages and costs arising from any reliance on the contents of this plan.

 $accept \ responsibility \ for \ the \ accuracy \ or \ completeness \ of \ this \ plan, its \ fitness \ for \ a \ particular \ purpose, or \ compliance \ with \ any \ regulatory \ requirements \ and \ standards. Further, the$



DESIGN Acacia House

DESIGNED FOR Brisbane - Option 2

Technical drawings should be read with the Acacia House Brisbane 'Design Options' document which includes building specifications and rating information.

DETAILS

Drawing title: Roof Plan


Scale: 1:100 Paper size: A3

Drawing number: 3/10

Date issued: March 2020





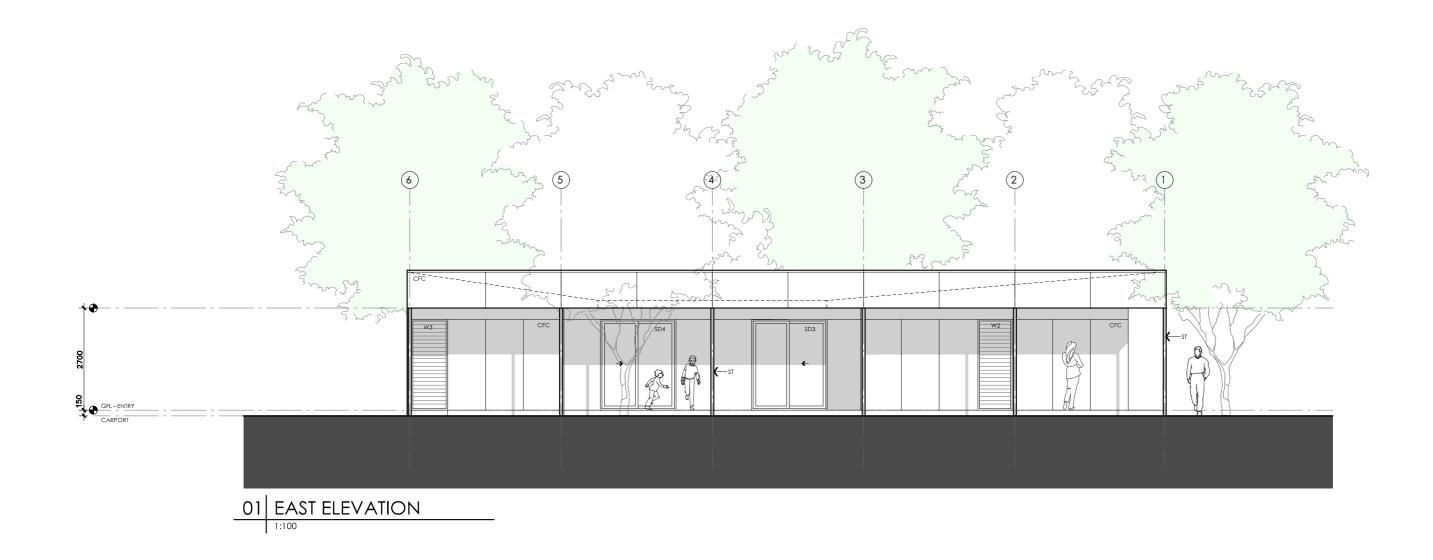

LEGEND

- BW FACE BRICK WALL TYPE & COLOUR TBC
- WB WEATHERBOARD CLADDING TYPE & COLOUR TBC
- CFC COMPRESSED FC SHEET ON TIMBER FRAME EXPRESSED JOINT AT EDGES INDICATED
- MF FOLDED METAL FASCIA COLOUR TBC
- ST STEEL WORK COLOUR TBC
- GD GARAGE DOOR COLOUR TBC
- ALUMINIUM COVER PLATE COLOUR TO MATCH WINDOW FRAMES

PROJECT







DESIGN Acacia House

DESIGNED FOR Brisbane - Option 2

Technical drawings should be read with the Acacia House Brisbane 'Design Options' document which includes building specifications and rating information.

DETAILS

Drawing title: Elevation

Scale: 1:100 Paper size: A3

Drawing number: 4/10 Date issued: March 2020 Project stage: Preliminary

DISCLAIMER



LEGEND

- BW FACE BRICK WALL TYPE & COLOUR TBC
- WB WEATHERBOARD CLADDING TYPE & COLOUR TBC
- CFC COMPRESSED FC SHEET ON TIMBER FRAME EXPRESSED JOINT AT EDGES INDICATED
- MF FOLDED METAL FASCIA COLOUR TBC
- ST STEEL WORK COLOUR TBC
- GD GARAGE DOOR COLOUR TBC
- ALUMINIUM COVER PLATE COLOUR TO MATCH WINDOW FRAMES

PROJECT







DESIGN Acacia House

DESIGNED FOR Brisbane - Option 2

Technical drawings should be read with the Acacia House Brisbane 'Design Options' document which includes building specifications and rating information.

DETAILS

Drawing title: Elevation

Scale: 1:100 Paper size: A3

Drawing number: 5/10 Date issued: March 2020 Project stage: Preliminary

DISCLAIMER



LEGEND

- BW FACE BRICK WALL TYPE & COLOUR TBC
- WB WEATHERBOARD CLADDING TYPE & COLOUR TBC
- CFC COMPRESSED FC SHEET ON TIMBER FRAME EXPRESSED JOINT AT EDGES INDICATED
- MF FOLDED METAL FASCIA COLOUR TBC
- ST STEEL WORK COLOUR TBC
- GD GARAGE DOOR COLOUR TBC
- ALUMINIUM COVER PLATE COLOUR TO MATCH WINDOW FRAMES

PROJECT

DISCLAIMER





This house plan is a guide only. It does not constitute legal or other professional advice. You should seek legal or other professional advice in relation to your specific

Commonwealth also disclaims liability, to the extent permitted by law, for any liabilities, losses, damages and costs arising from any reliance on the contents of this plan.

circumstances before adopting any recommendation made within it e.g. advice on structural engineering or building certification requirements. The Commonwealth does not

accept responsibility for the accuracy or completeness of this plan, its fitness for a particular purpose, or compliance with any regulatory requirements and standards. Further, the



DESIGN Acacia House

DESIGNED FOR Brisbane - Option 2


Technical drawings should be read with the Acacia House Brisbane 'Design Options' document which includes building specifications and rating information.

DETAILS

Drawing title: Elevation

Scale: 1:100 Paper size: A3

Drawing number: 6/10 Date issued: March 2020 Project stage: Preliminary

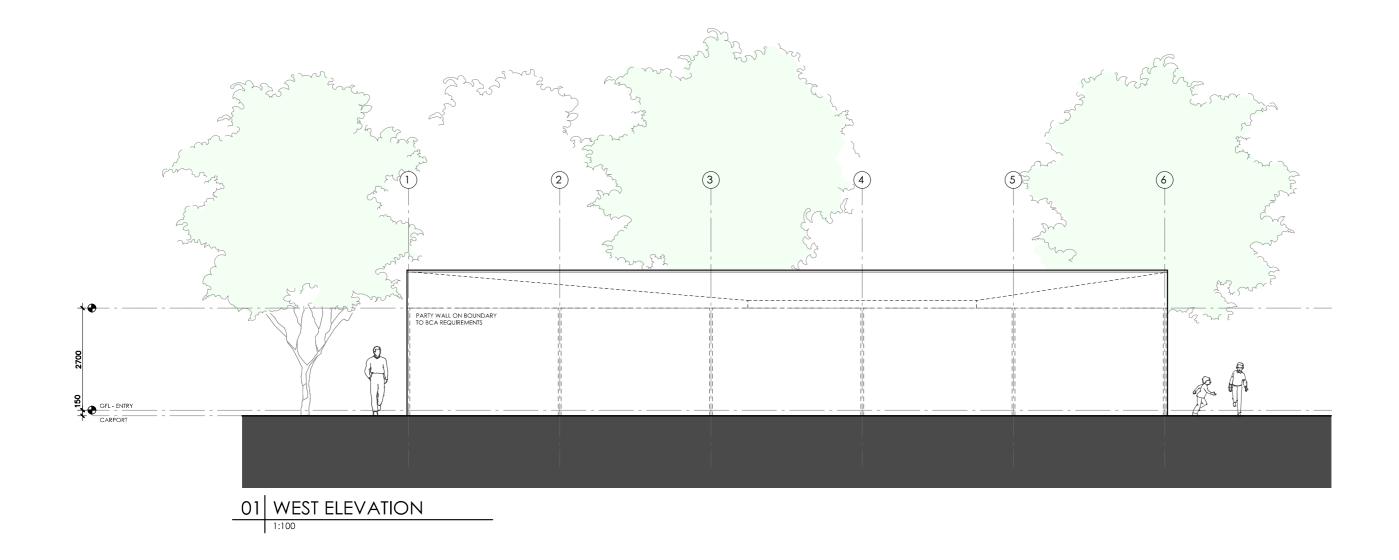

LEGEND

- BW FACE BRICK WALL TYPE & COLOUR TBC
- WB WEATHERBOARD CLADDING TYPE & COLOUR TBC
- CFC COMPRESSED FC SHEET ON TIMBER FRAME EXPRESSED JOINT AT EDGES INDICATED
- MF FOLDED METAL FASCIA COLOUR TBC
- ST STEEL WORK COLOUR TBC
- GD GARAGE DOOR COLOUR TBC
- ALUMINIUM COVER PLATE COLOUR TO MATCH WINDOW FRAMES

PROJECT







DESIGN Acacia House

DESIGNED FOR Brisbane - Option 2

Technical drawings should be read with the Acacia House Brisbane 'Design Options' document which includes building specifications and rating information.

DETAILS

Drawing title: Elevation

Scale: 1:100 Paper size: A3

Drawing number: 7/10 Date issued: March 2020 Project stage: Preliminary

DISCLAIMER



LEGEND

- BW FACE BRICK WALL TYPE & COLOUR TBC
- WB WEATHERBOARD CLADDING TYPE & COLOUR TBC
- CFC COMPRESSED FC SHEET ON TIMBER FRAME EXPRESSED JOINT AT EDGES INDICATED
- MF FOLDED METAL FASCIA COLOUR TBC
- ST STEEL WORK COLOUR TBC
- GD GARAGE DOOR COLOUR TBC
- ALUMINIUM COVER PLATE COLOUR TO MATCH WINDOW FRAMES

PROJECT

DISCLAIMER





This house plan is a guide only. It does not constitute legal or other professional advice. You should seek legal or other professional advice in relation to your specific

Commonwealth also disclaims liability, to the extent permitted by law, for any liabilities, losses, damages and costs arising from any reliance on the contents of this plan.

circumstances before adopting any recommendation made within it e.g. advice on structural engineering or building certification requirements. The Commonwealth does not

accept responsibility for the accuracy or completeness of this plan, its fitness for a particular purpose, or compliance with any regulatory requirements and standards. Further, the



DESIGN Acacia House **DESIGNED FOR**

Brisbane - Option 2


Technical drawings should be read with the Acacia House Brisbane 'Design Options' document which includes building specifications and rating information.

DETAILS

Drawing title: Section

Scale: 1:100 Paper size: A3

Drawing number: 8/10 Date issued: March 2020 Project stage: Preliminary

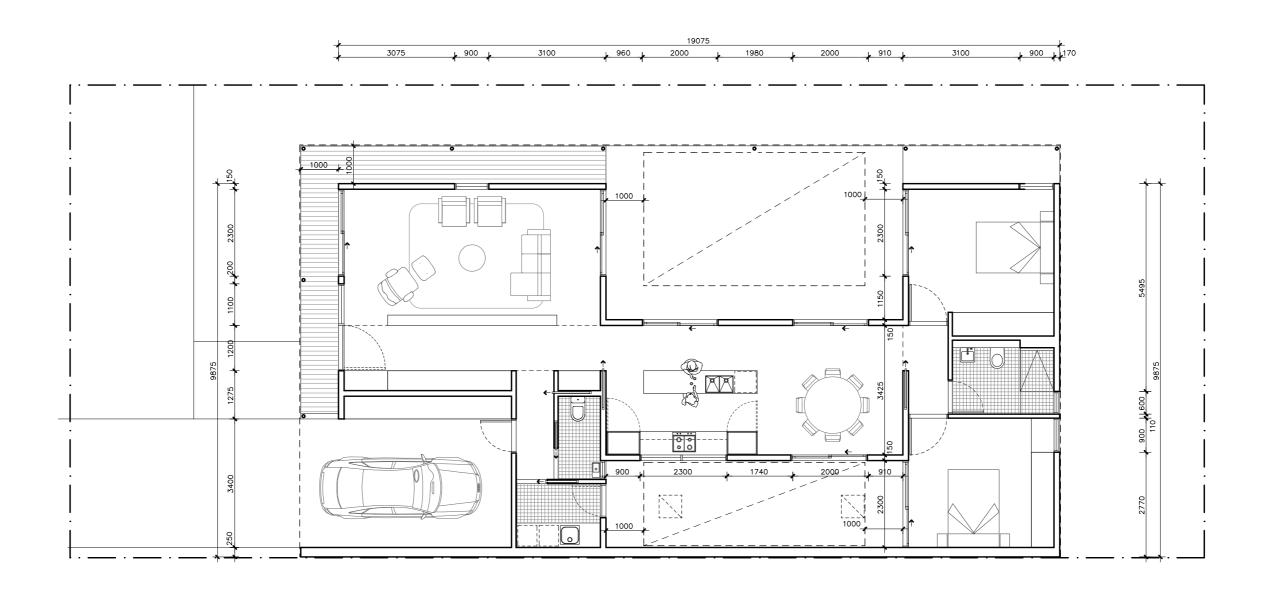

LEGEND N/A

PROJECT

DISCLAIMER





This house plan is a guide only. It does not constitute legal or other professional advice. You should seek legal or other professional advice in relation to your specific

Commonwealth also disclaims liability, to the extent permitted by law, for any liabilities, losses, damages and costs arising from any reliance on the contents of this plan.

circumstances before adopting any recommendation made within it e.g. advice on structural engineering or building certification requirements. The Commonwealth does not

accept responsibility for the accuracy or completeness of this plan, its fitness for a particular purpose, or compliance with any regulatory requirements and standards. Further, the



DESIGN Acacia House

DESIGNED FOR

Brisbane - Option 2

Technical drawings should be read with the Acacia House Brisbane 'Design Options' document which includes building specifications and rating information.

DETAILS

Drawing title: Wall Setout Plan

Scale: 1:100
Paper size: A3

Drawing number: 9/10

Date issued: March 2020

Project stage: Preliminary



REFERENCE	HEIGHT	WIDTH	TYPE	NOTES
D1	2400mm	1100mm	Solid door	1000mm Eave at 2700mm above Finished Floor Level
SD1	2400mm	2300mm	Glazed sliding door	1000mm Eave at 2700mm above Finished Floor Level
W1	2400mm	1100mm	Fixed window	1000mm Eave at 2700mm above Finished Floor Level
W2	2400mm	900mm	Louvres	1000mm Eave at 2700mm above Finished Floor Level See elevations for breakdown of opening types
SD2	2400mm	2300mm	Glazed sliding door	1000mm Eave at 2700mm above Finished Floor Level
SD3	2400mm	2000mm	Glazed sliding door	1000mm Eave at 2700mm above Finished Floor Level
SD4	2400mm	2000mm	Glazed sliding door	1000mm Eave at 2700mm above Finished Floor Level
SD5	2400mm	2300mm	Glazed sliding door	1000mm Eave at 2700mm above Finished Floor Level
W3	2400mm	900mm	Louvres	1000mm Eave at 2700mm above Finished Floor Level See elevations for breakdown of opening types
W4	1440mm	600mm	Awning window	
W5	2400mm	900mm	Louvres	See elevations for breakdown of opening types
SD6	2400mm	2300mm	Glazed sliding door	1000mm Eave at 2700mm above Finished Floor Level
SD7	2400mm	2000mm	Glazed sliding door	
W6	800mm	2300mm	Fixed window	
W7	600mm	600mm	Sliding window	1000mm Eave at 2700mm above Finished Floor Level
D2	2250mm	820mm	Glazed hinged door	1000mm Eave at 2700mm above Finished Floor Level

LEGEND

N/A

PROJECT







Acacia House

DESIGN

DESIGNED FOR

Brisbane - Option 2

Technical drawings should be read with the Acacia House Brisbane 'Design Options' document which includes building specifications and rating information.

DETAILS

Drawing title: Window and Door

Schedule

Scale: N/A
Paper size: A3

Drawing number: 10/10

Date issued: March 2020

Project stage: Preliminary

DISCLAIMER